

KEY MAP
1" = 5'

UTILITY LEGEND

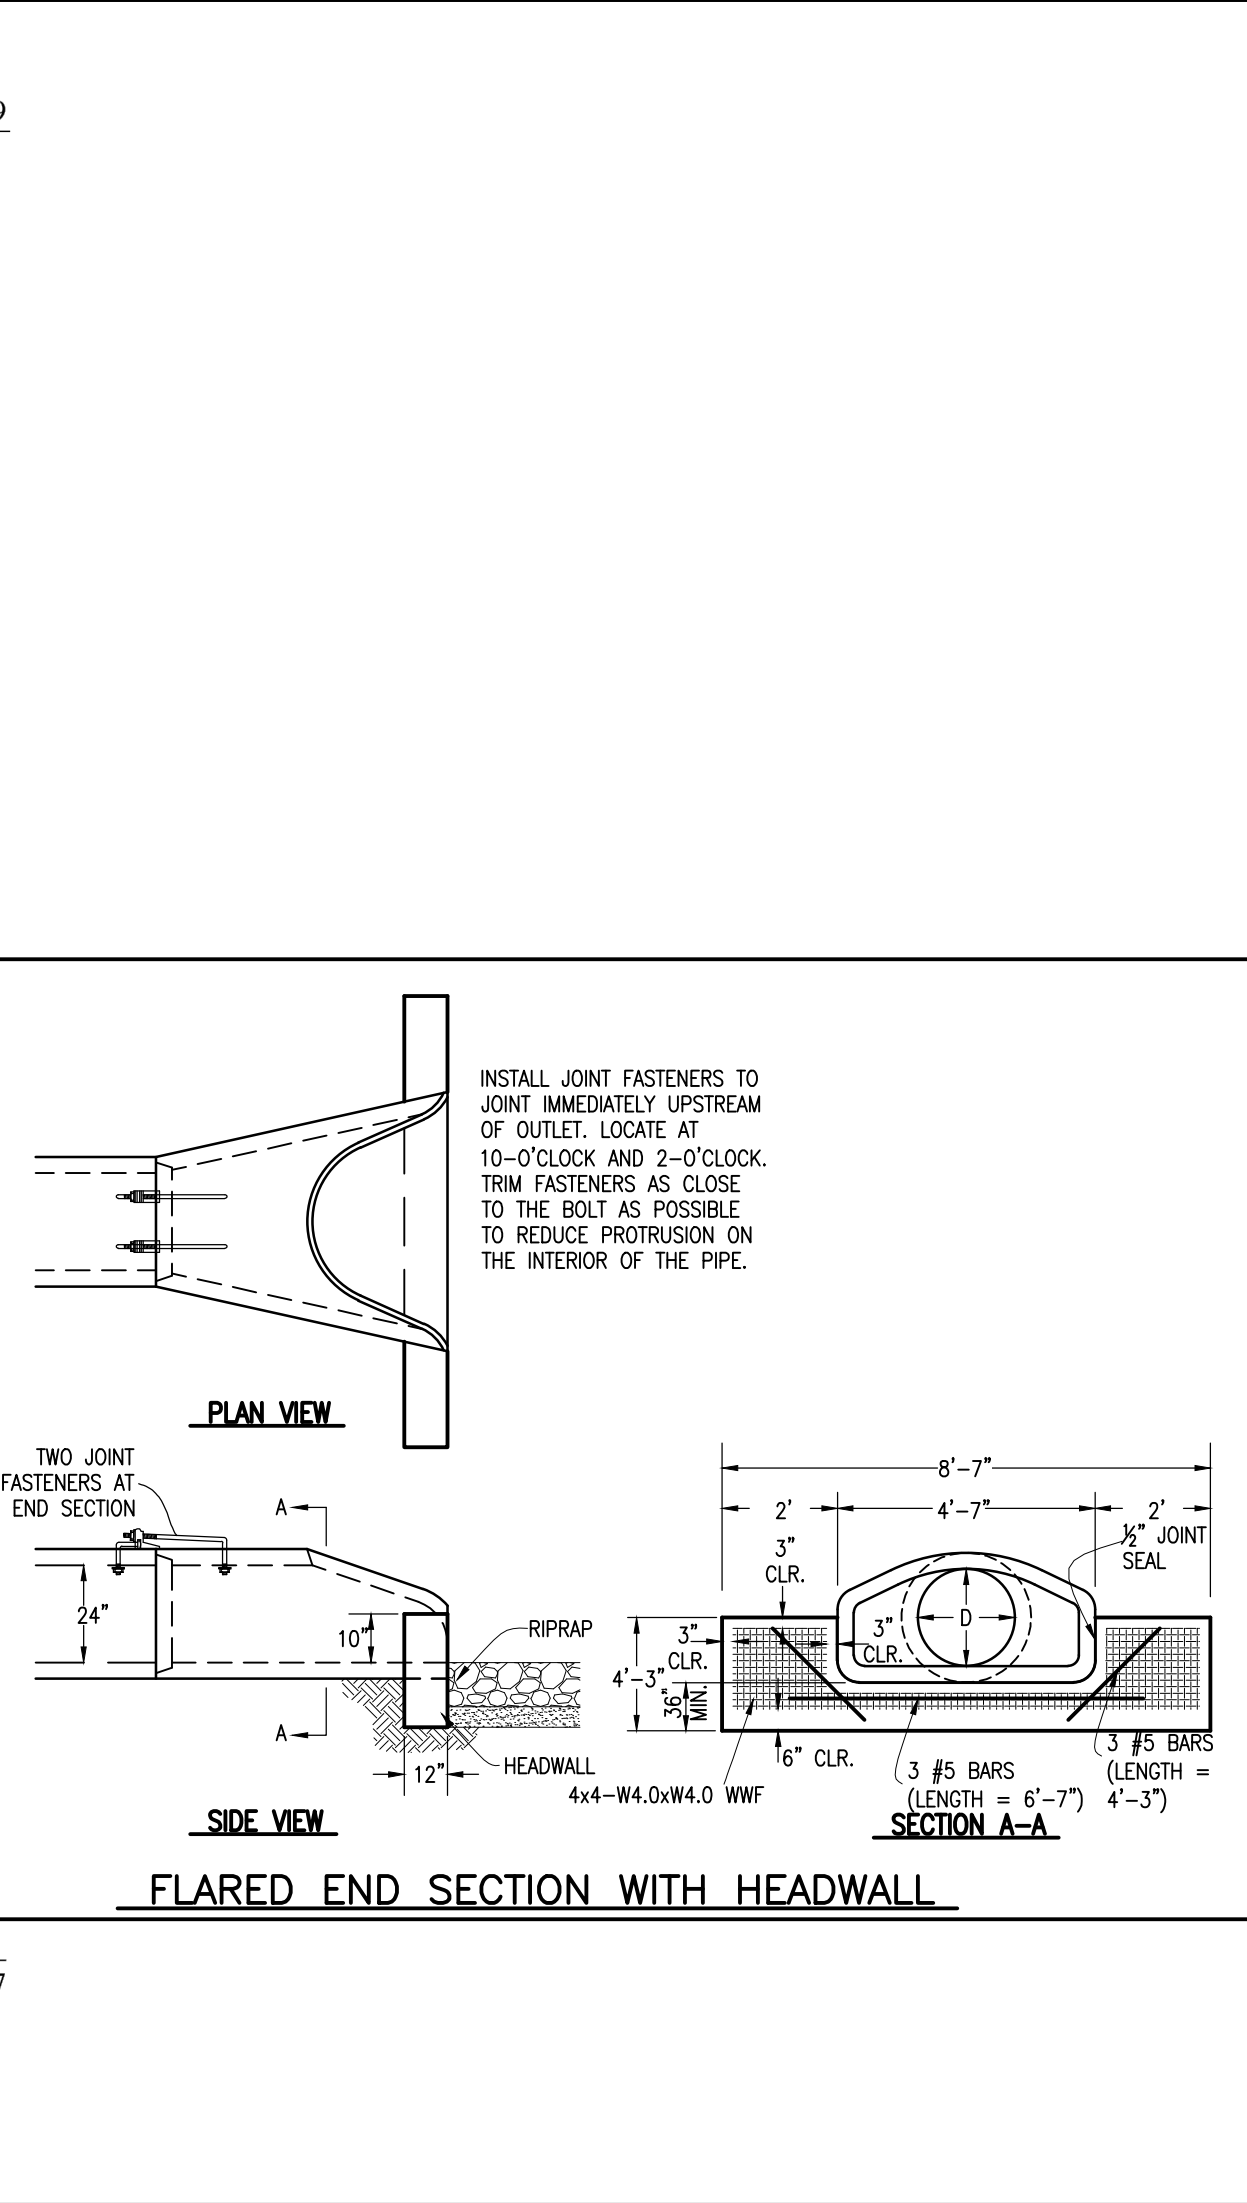
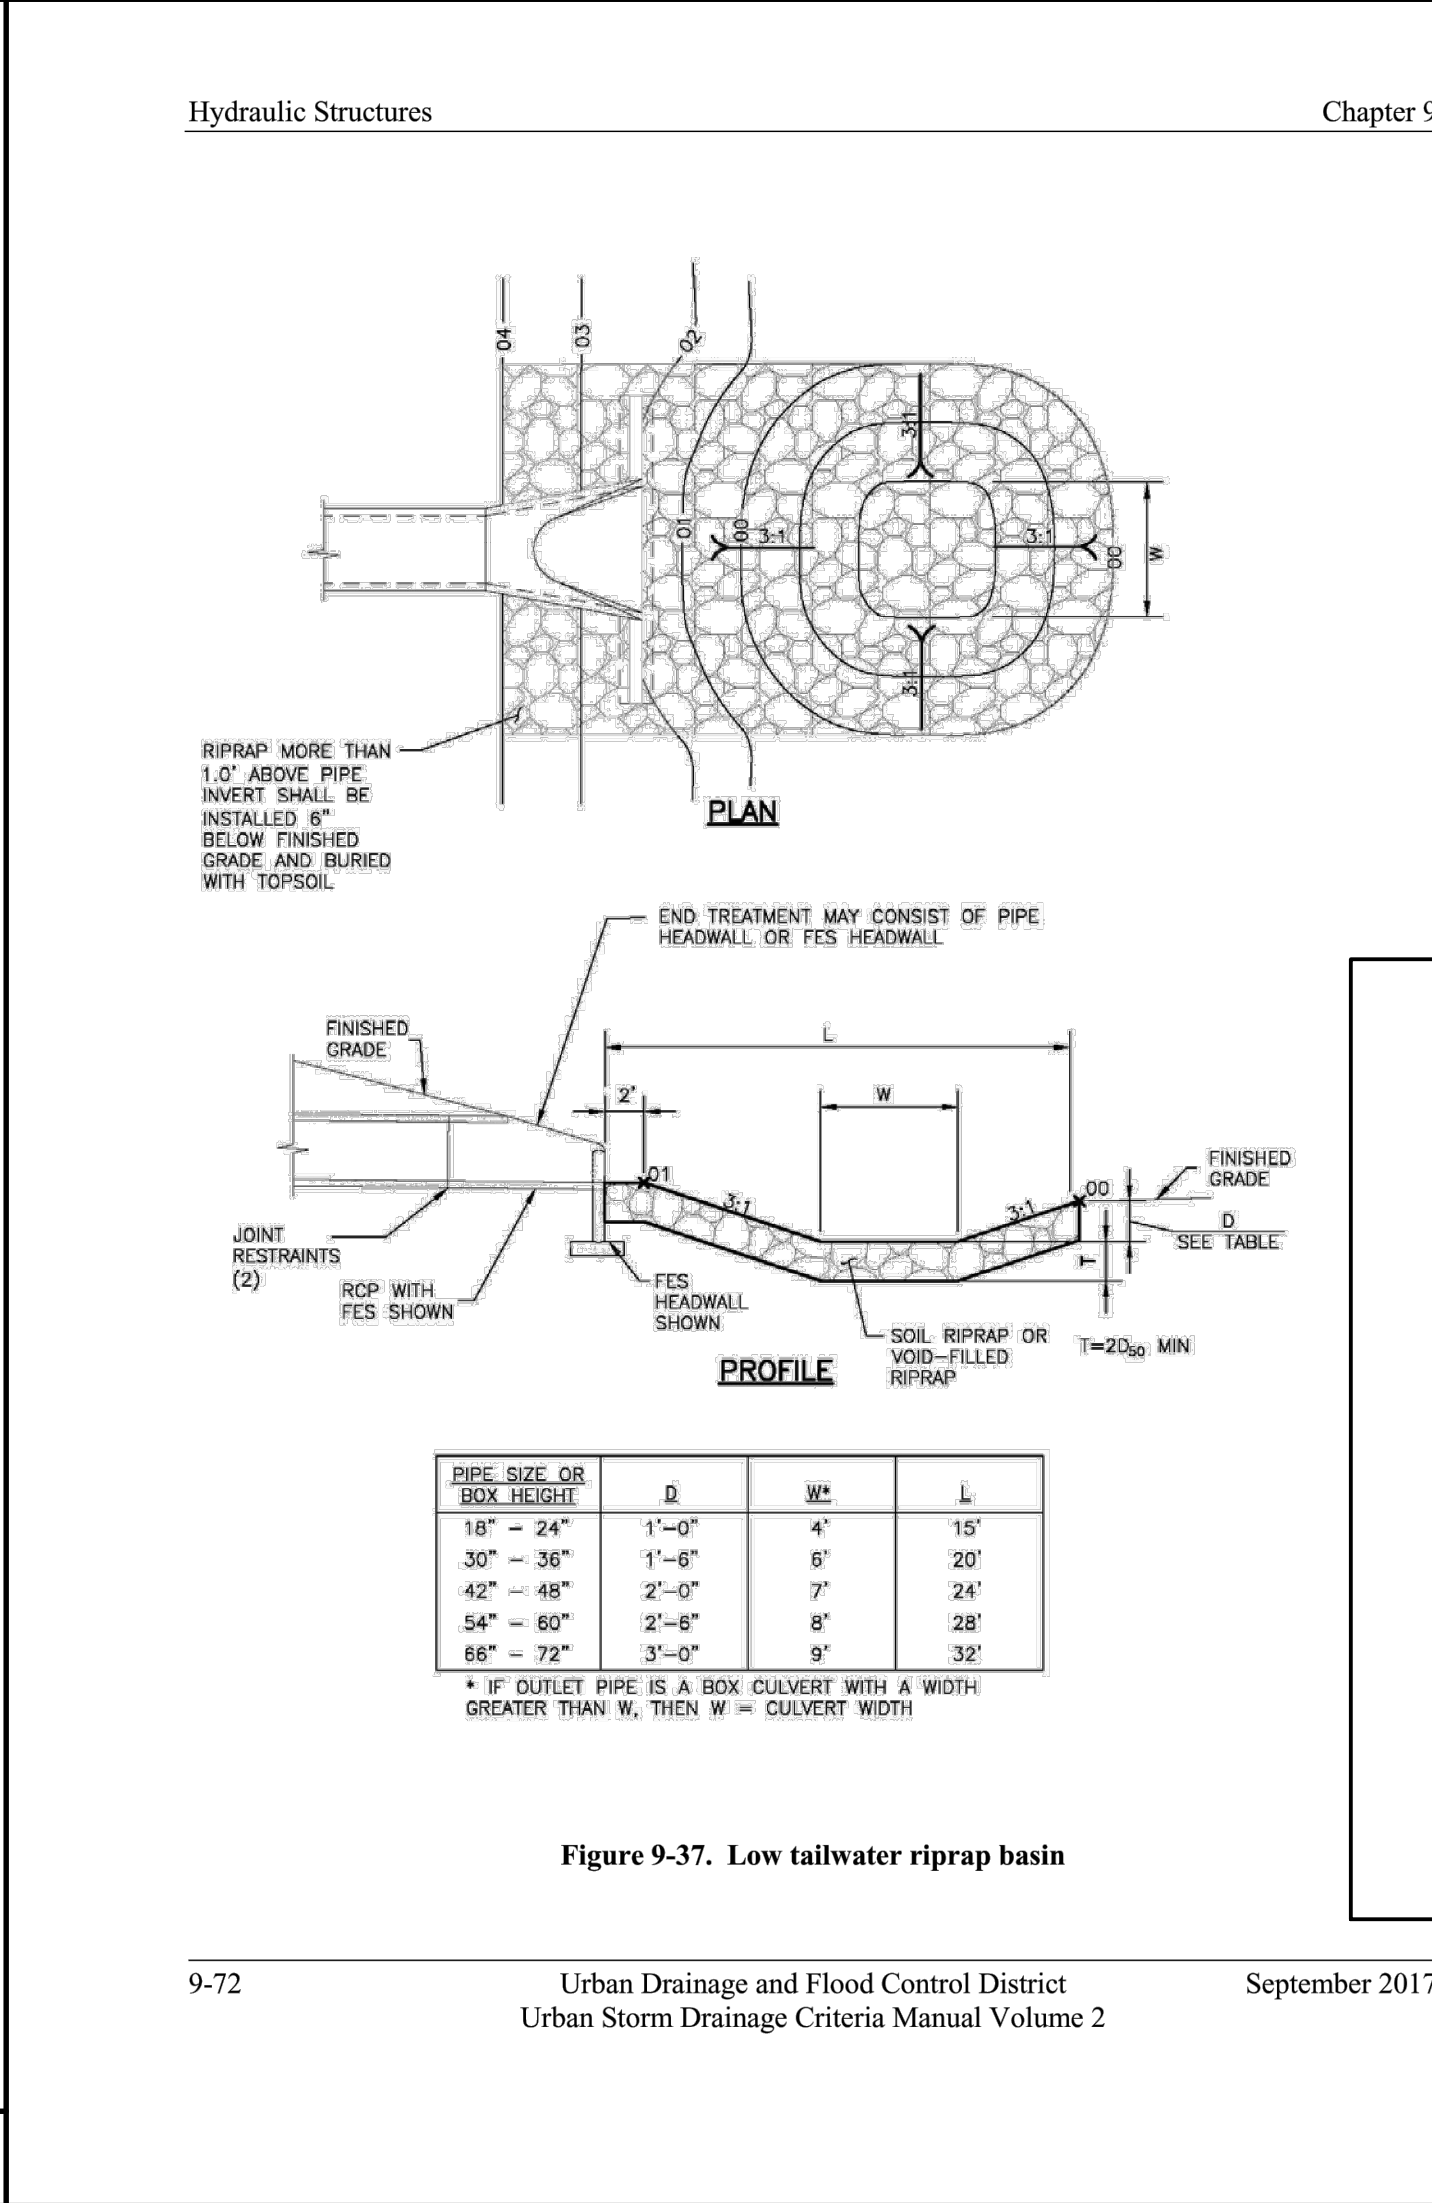
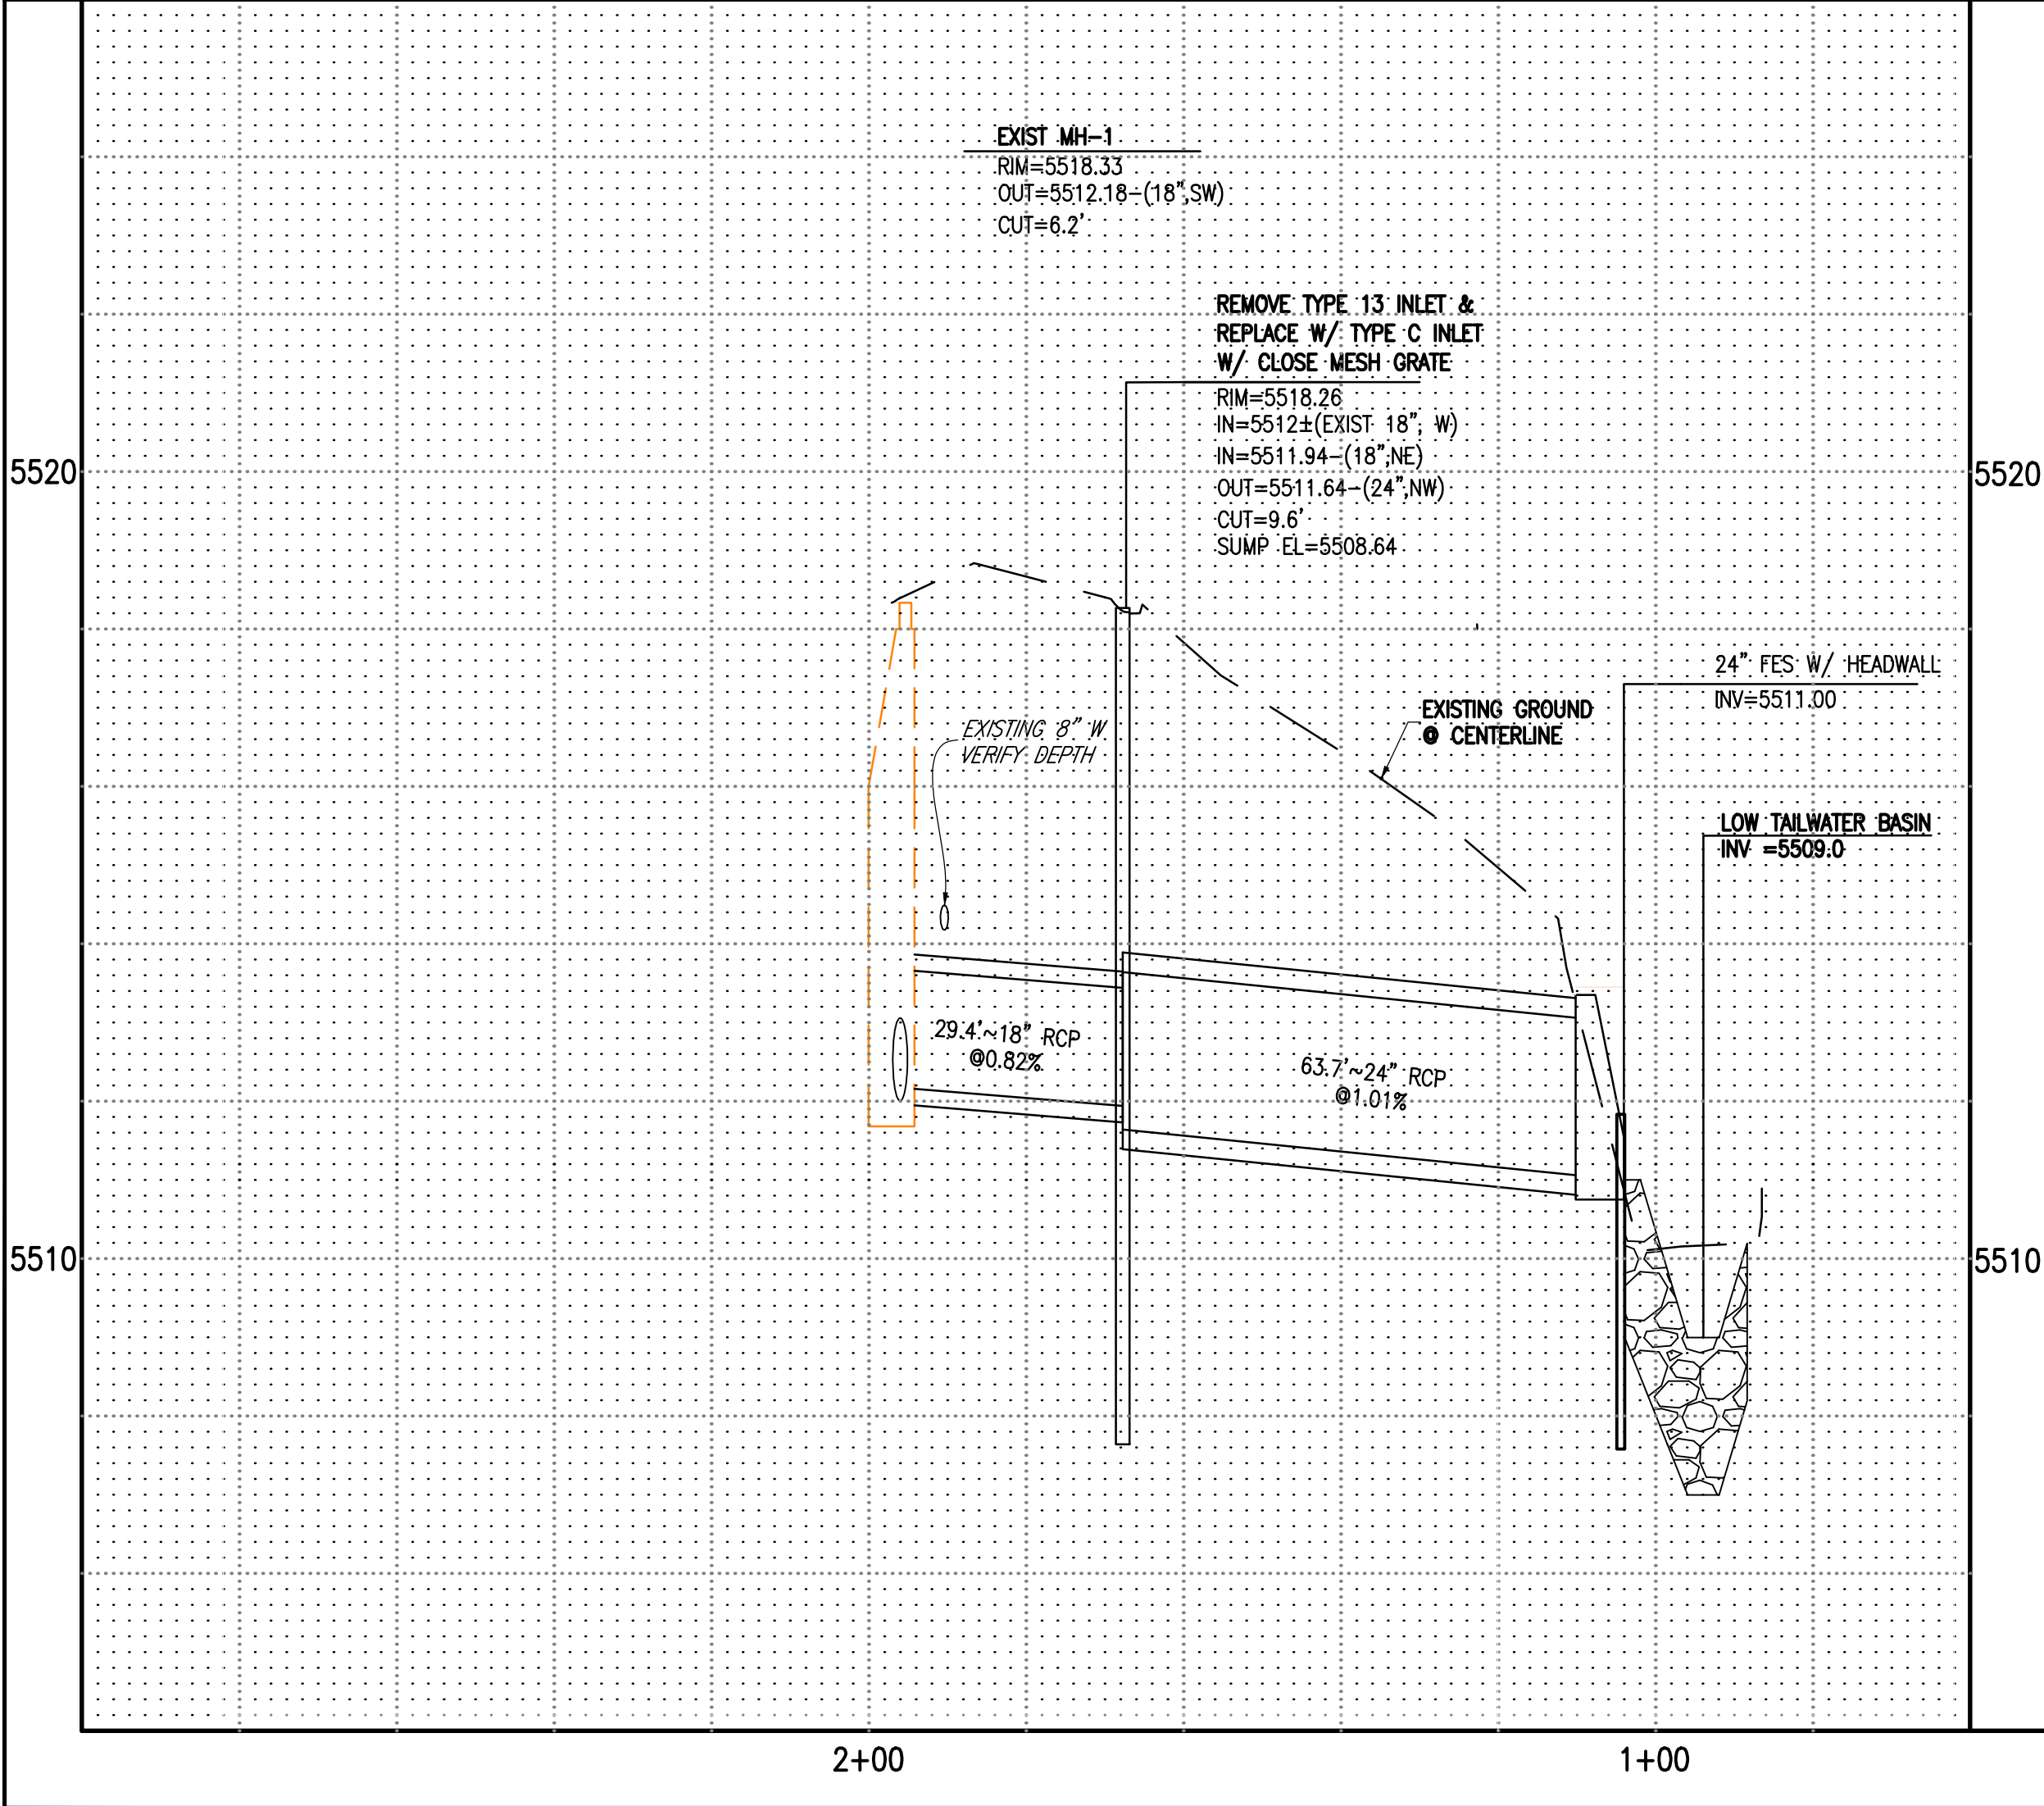
PROPOSED	UTILITY	EXISTING
	STORM SEWER, MANHOLE, INLET	
	SANITARY SEWER & MANHOLE	
	WATER MAIN, FIRE HYDRANT, VALVE, REDUCER, & CROSS	
	BENDS W/THRUST BLOCK, CHECK VALVE, & PLUG W/ BLOWOFF	
	SANITARY SEWER SERVICE	
	WATER SERVICE, METER	
	CABLE TV	
	ELECTRIC	
	GAS LINE	
	TELEPHONE	
	OVERHEAD ELECTRIC	
	OVERHEAD TELEPHONE	
	FIBER OPTIC LINE	

GENERAL LEGEND

RIGHT-OF-WAY CENTERLINE	EXISTING EASEMENT	PROPOSED EASEMENT	EXISTING LOT/R.O.W LINE	PROPOSED LOT/R.O.W LINE	BOUNDARY LINE	EXISTING 5' CONTOUR	PROPOSED 5' CONTOUR	PROPOSED 1' CONTOUR	EDGE OF PAVEMENT	FENCE	EDGE OF GRAVEL

REUSE OF DOCUMENT
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SHEET NOTES

- CONTRACTOR TO LOCATE EXISTING WATER LINE VERTICALLY AND HORIZONTALLY ADJACENT TO PROPOSED STORM SEWER CONSTRUCTION AND REPORT TO ENGINEER ANY DISCREPANCIES.
- SEE CONSTRUCTION PLANS FOR WINDERMERE TRAIL FOR ADDITIONAL NOTES AND DETAILS. THIS PLAN IS INTENDED TO REPLACE THE STORM SEWER CONSTRUCTION PLAN INDICATED ON SHEET 7.

ENGINEER CERTIFICATION

I HEREBY CERTIFY THAT THE CONSTRUCTION DOCUMENTS WERE PREPARED BY ME (OR UNDER MY DIRECT SUPERVISION) IN ACCORDANCE WITH THE PROVISIONS OF THE CITY OF LITTLETON'S OPERATING STANDARDS FOR THE OWNERS THEREOF.

BENCHMARK

10' WITNESS CORNER TO SOUTH 1/4 SECTION 28, 3/4" ALUMINUM CAP SET IN CONCRETE SIDEWALK AT SOUTH END OF SOUTH WINDERMERE STREET CUL-DE-SAC, SOUTH OF HINSDALE COURT PLS 35585, ELEV = 5529.23 (NAVD 88)

CITY OF LITTLETON APPROVALS

DESIGNED BY	DRAWN BY	CHECKED BY	APPROVED BY
BMS	BMS	DJO	BOM

REVISIONS

NO.	DESCRIPTION	DATE
1		

WINDERMERE TRAIL
HIGHLINE CANAL
STORM SEWER OUTFALL
PLAN AND PROFILE

DATE: 09/20/2019
JOB NO: 13100.00
SCALE: HORIZONTAL 1"=20' VERTICAL 1"=2'
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