## CONVERSTION OF OUTDOOR SITTING INTO COVERED PATIO

# 2399 W MAIN ST LITTLETON, CO 80120 UNITED STATES

### DRAWING LIST:

A0 COVER PAGE/EXISTING CONDITION

A1 SITE PLAN

A2 PROPOSED FLOOR PLAN

ROOF PLAN & ELECTRICAL PLAN

A4 ELEVATIONS A5 ELECTRICAL

#### **GENERAL NOTES:**


- 1. IT IS THE CONTRACTOR'S RESPONSIBILITY TO FIELD VERIFY THE EXACT LOCATION OF ALL UTILITY SERVICES AND SLOPE PRIOR TO BID/INSTALLATION.
- 2. CONTRACTOR SHALL FIELD VERIFY ALL EXISTING CONDITIONS BEFORE COMMENCING WORK AND REPORT ANY AND ALL DISCREPANCIES BETWEEN ACTUAL CONDITIONS AND THESE PLANS TO THE ENGINEER/ARCHITECT IMMEDIATELY.
- 3. CONTRACTOR SHALL MAKE ALL NECESSARY MODIFICATIONS DURING THE CONSTRUCTION PROCESS TO COMPLY WITH I.R.C. (INTERNATIONAL RESIDENTIAL CODE), LATEST EDITION, OR APPLICABLE CODES AT SITE.
- 4. CONTRACTOR SHALL VERIFY ALL INTERIOR FINISHES, FLOOR COVERINGS, AND TRIM SIZES & CONFIGURATIONS WITH OWNER PRIOR TO CONSTRUCTION.
- 5. IT IS THE SOLE RESPONSIBILITY OF THE CONTRACTOR TO VERIFY CLEARANCES OF THE ITEMS MENTIONED IN THE DRAWINGS PRIOR TO THE CONSTRUCTION.
- 6. EXTERIOR WALL AND ROOF FINISHES AS PER CUSTOMER'S CHOICE.
- 7. REFER TO MANUFACTURER'S SPECS FOR ROUGH OPENING DIMENSIONS, FOR DOOR AND WINDOWS.
- 8. ALL BEAMS SIZES TO BE VERIFIED BY THE STRUCTURAL ENGINEER


## CODE REQUIREMENTS:

- 2022 INTERNATIONAL BUILDING CODE W/ LOCAL AMENDMENTS
- 2022 INTERNATIONAL EXISTING BUILDING CODE
- 2022 INTERNATIONAL PLUMBING CODE W/ LOCAL AMENDMENTS
- 2022 INTERNATIONAL MECHANICAL CODE W/ LOCAL AMENDMENTS
  - 2022 INTERNATIONAL FUEL GAS CODE W/ LOCAL AMENDMENTS
- 2022 DENVER BUILDING AND FIRE CODE
  - 2022 INTERNATIONAL ENERGY CONSERVATION CODE
- 2022 NATIONAL ELECTRICAL CODE W/ LOCAL AMENDMENTS
  - 2022 ICC/ANSI A-117.1 ACCESSIBLE AND USABLE BUILDINGS & FACILITIES


## PROJECT INFORMATION:

- CONVERSATION OF EXISTING SITTING TO COVERED PATIO
- WORK WILL BE DONE CIVIL, LIGHTING, ELECTRICAL AND PLUMBING

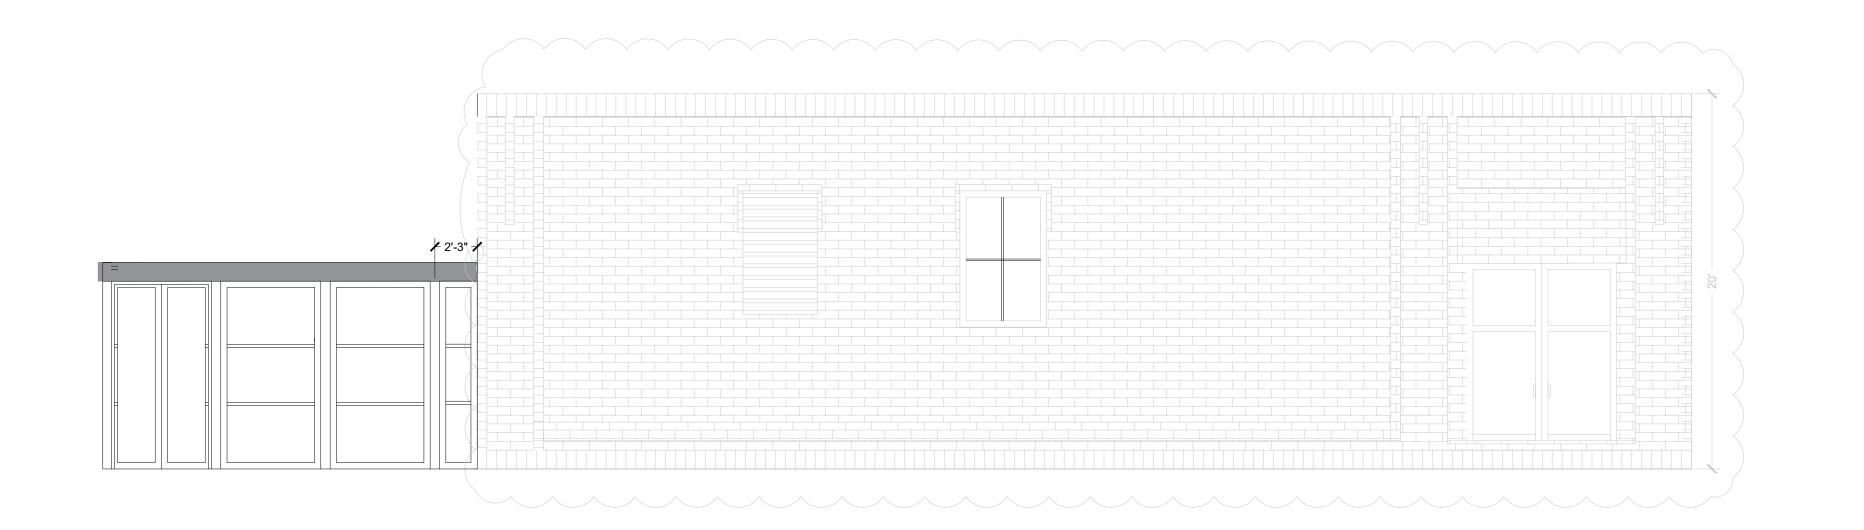

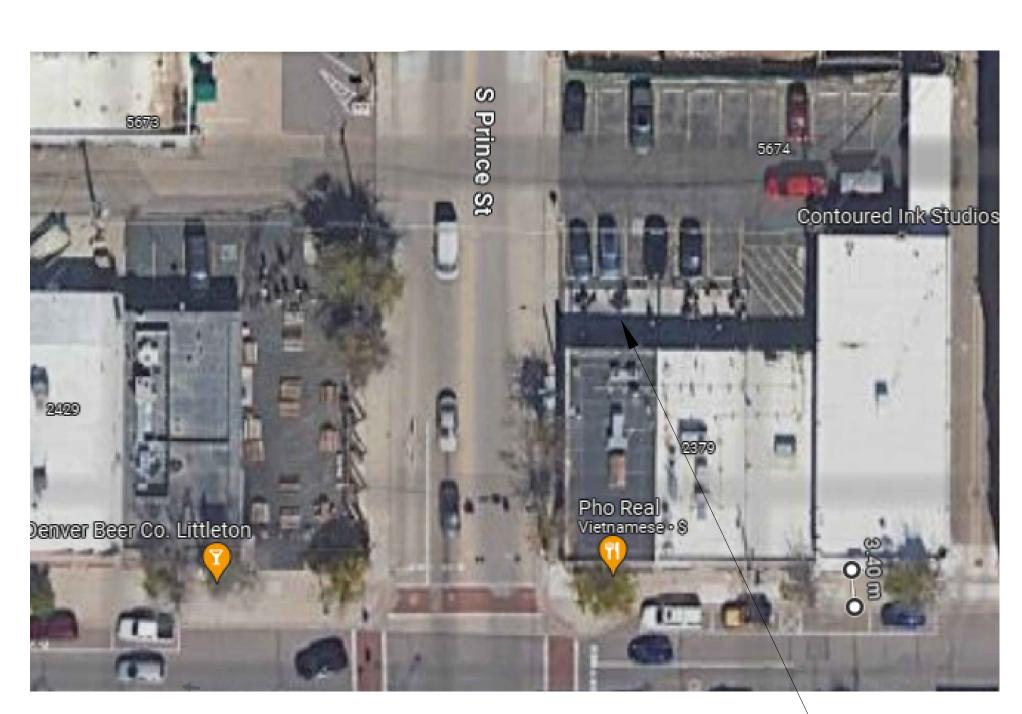



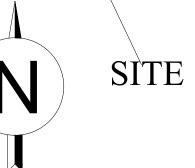



DWGNO

REVISION:

AS-SHOWN
DATE:


ORESS:
I ST LITTLETON, CO
D STATES

THECONTRACTOR29

O PROJECT ADDRESS:
2399 W MAIN ST LITT
80120 UNITED STATE

DRAWING TITLE: TITTLE PAGE

THOUGH GREAT EFFORT AND CARE HAVE GONE INTO THE PREPARATION OF THIS HON AN, IT IS IMPOSSIBLE TO AFFECT ANY CONTROL OVER THE ACTUAL CONSTRUCTION. FO AT REASON AND DUE TO THE MANY JURISDICTIONAL DIFFERENCES IN LOCAL BUILDIN DE REQUIREMENTS AND OTHER LOCAL SEISMIC AND WEATHER CONDITIONS, "KA. SIGN" ASSUMES NO RESPONSIBILITY FOR ANY DAMAGES, MONETARY OR OTHERWIS LUDING STRUCTURAL FAILURES DUE TO ANY DEFICIENCIES, OMISSIONS, OR ERRORS E DESIGN. HOME PLANS ARE GENERAL IN NATURE. IT IS THE RESPONSIBILITY OF THE NER AND BUILDER TO CONSULT A LOCAL ARCHITECT OR ENGINEER AND TO CHECK WIT CAL BUILDING OFFICIALS BEFORE THE START OF CONSTRUCTION. ADDITIONAL GINEERING AND DESIGN MAY BE REQUIRED TO COMPLY WITH LOCAL BUILDING CODES.

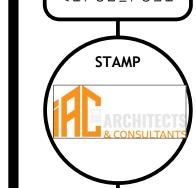


DRAWINGS PROVIDED BY:


ARCHITECTS

ENGRIEBEING SOLUTION & CONSULTANS

ARCHITECTURE, (M.E.P.) CONSULTANT, QUANTITY SURVEYOR, WWW.fivetr.com/kami\_filler

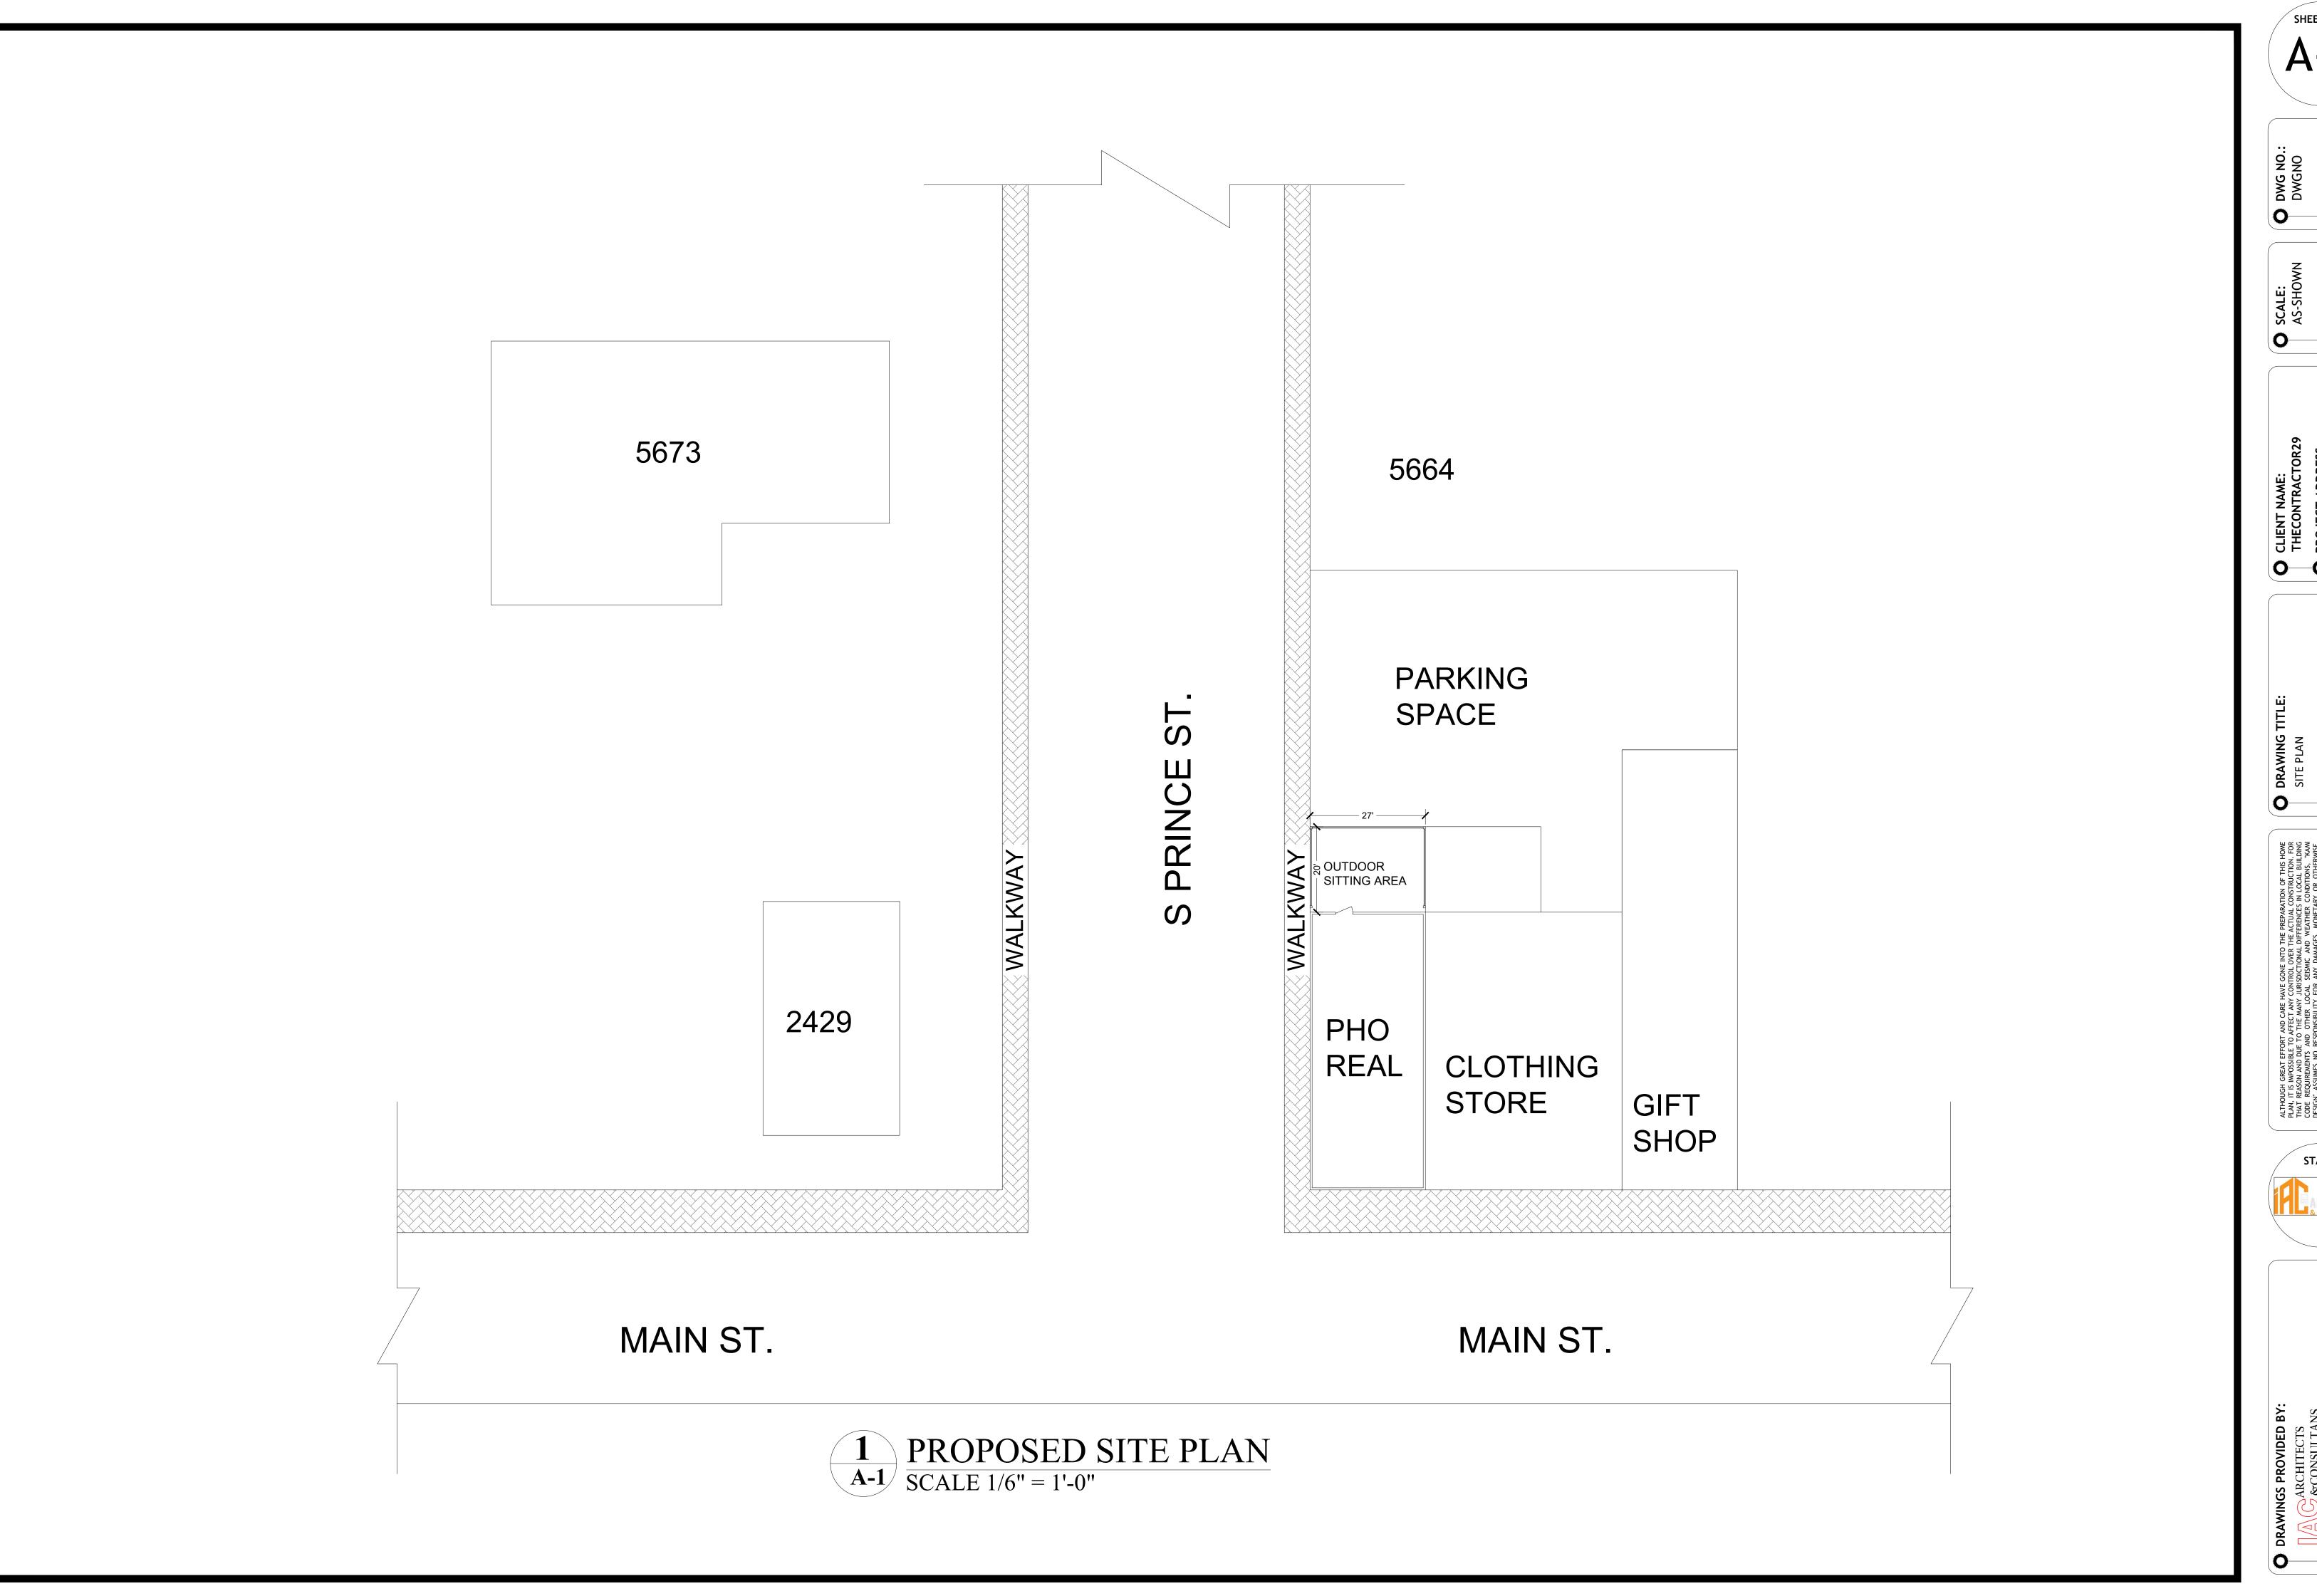




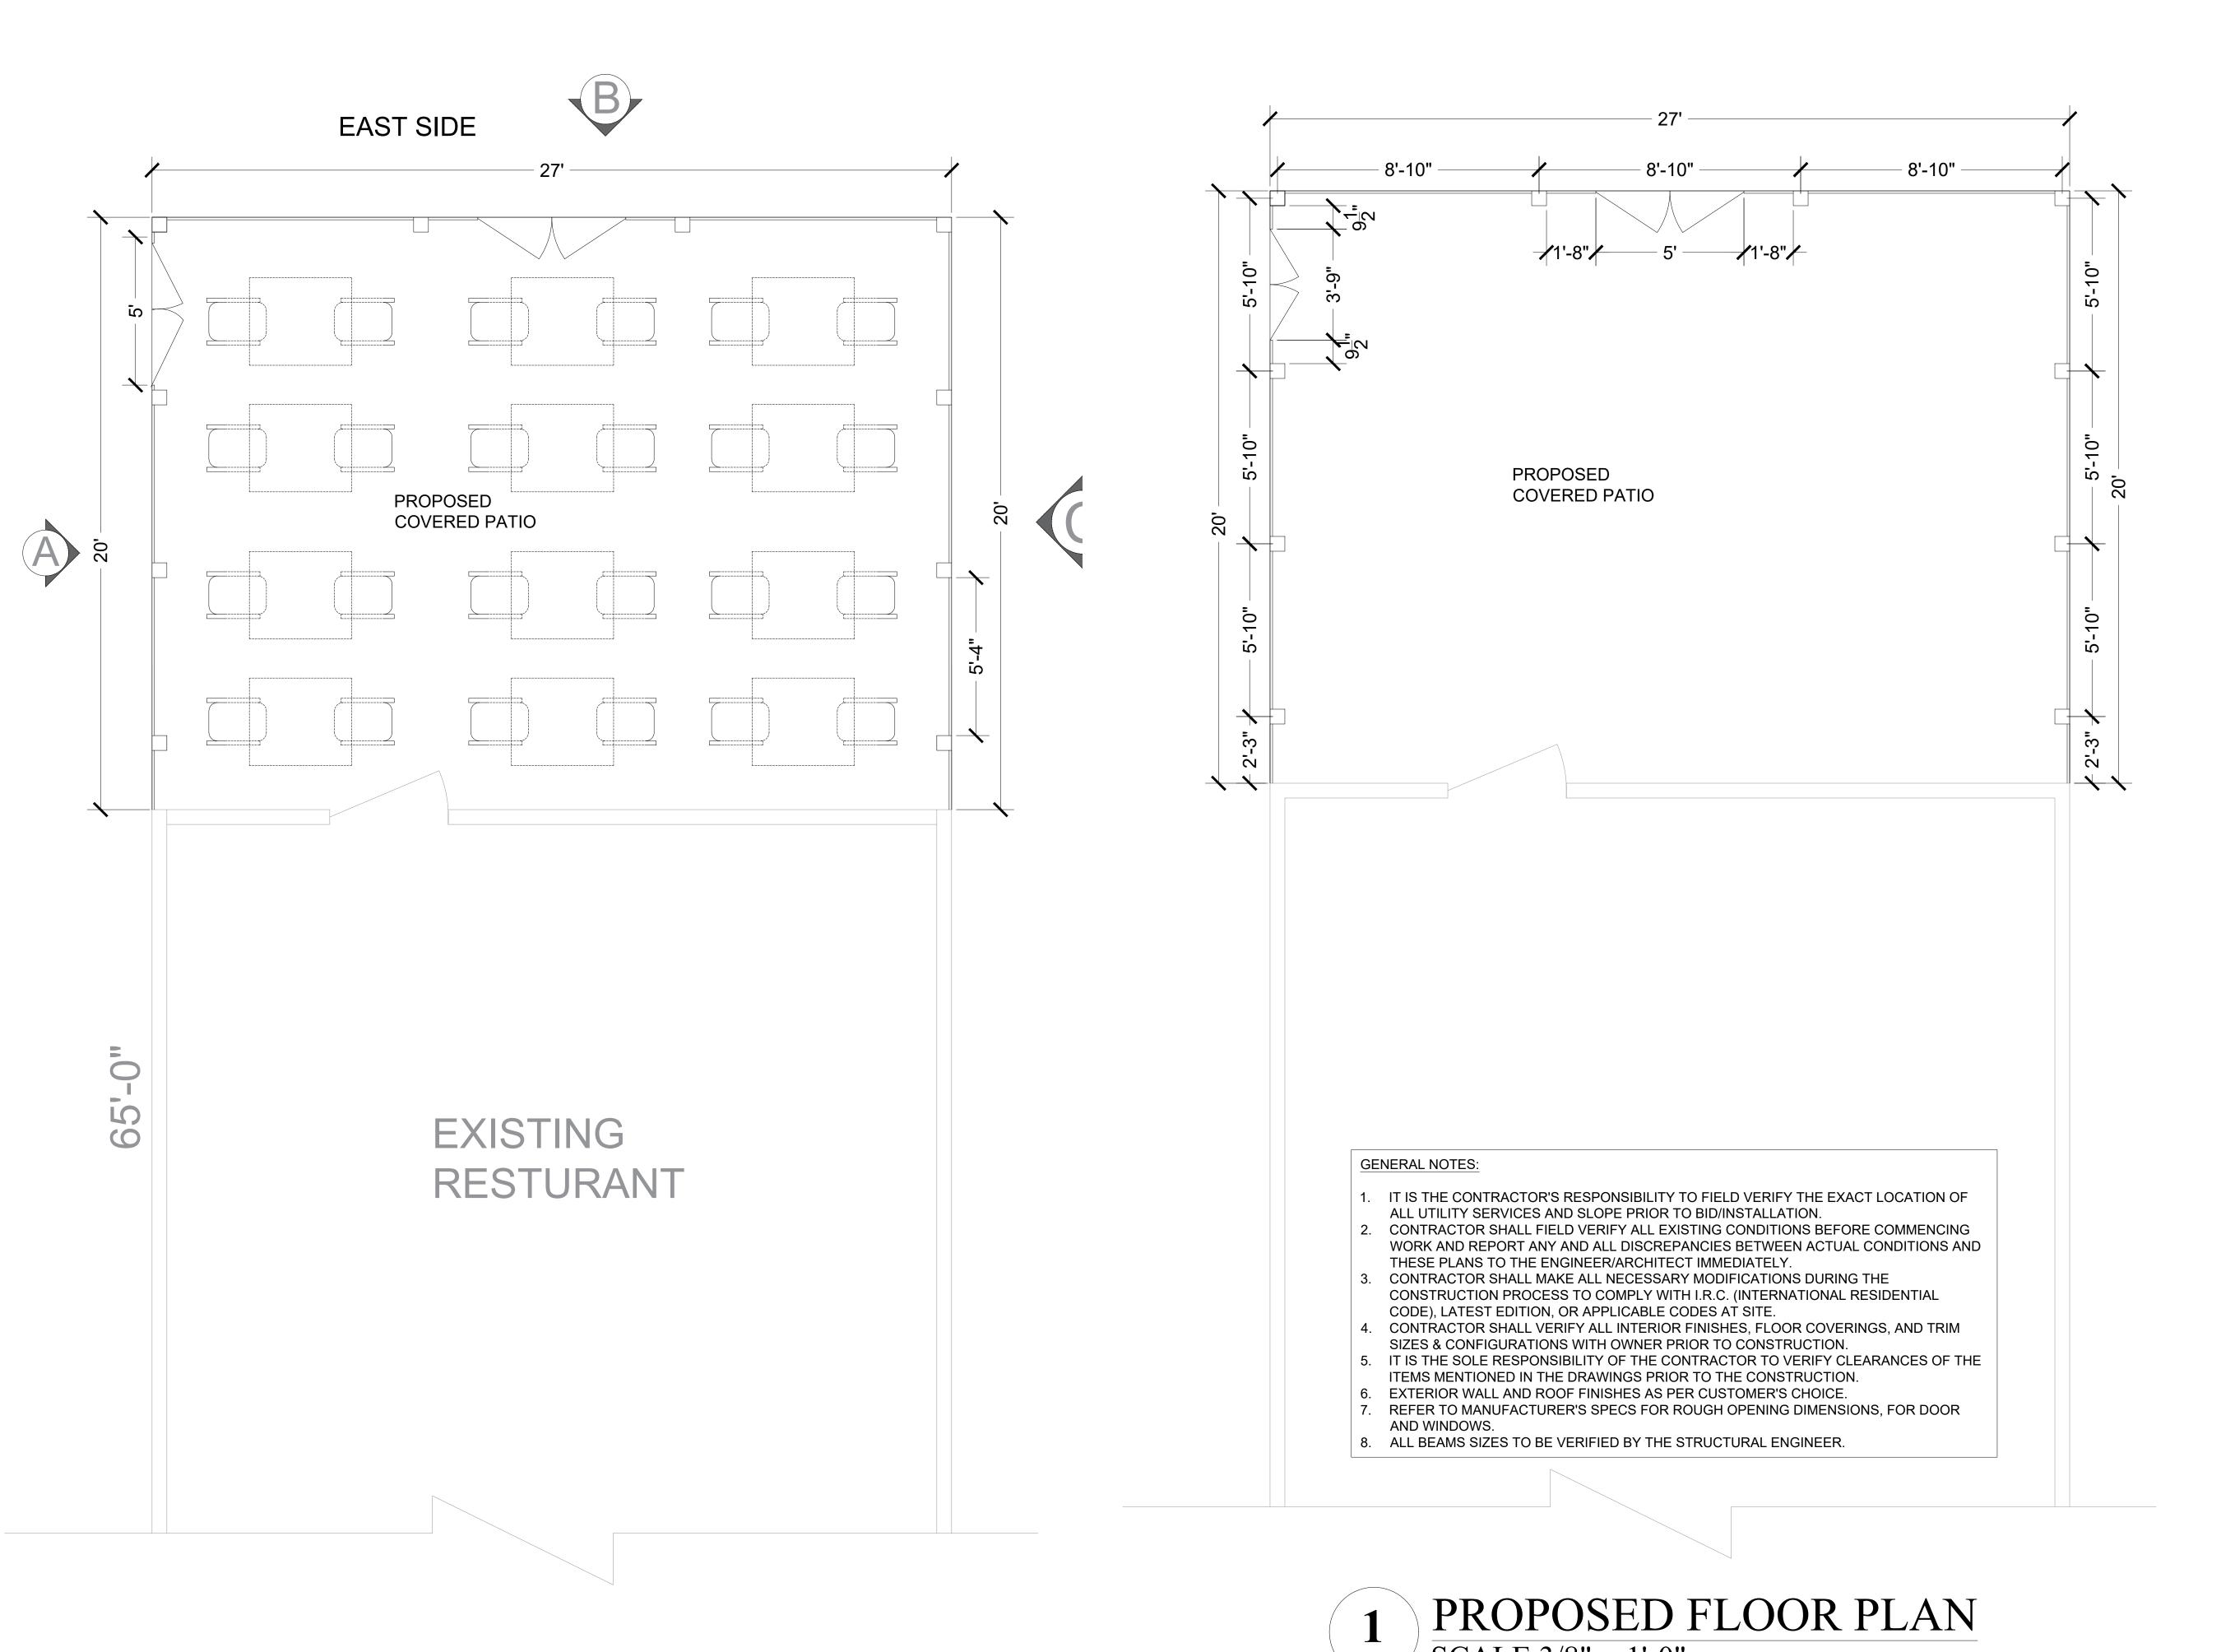

PROPOSED SITE PLAN

SCALE 3/8" = 1'-0"


SCALE 3/8" = 1'-0"

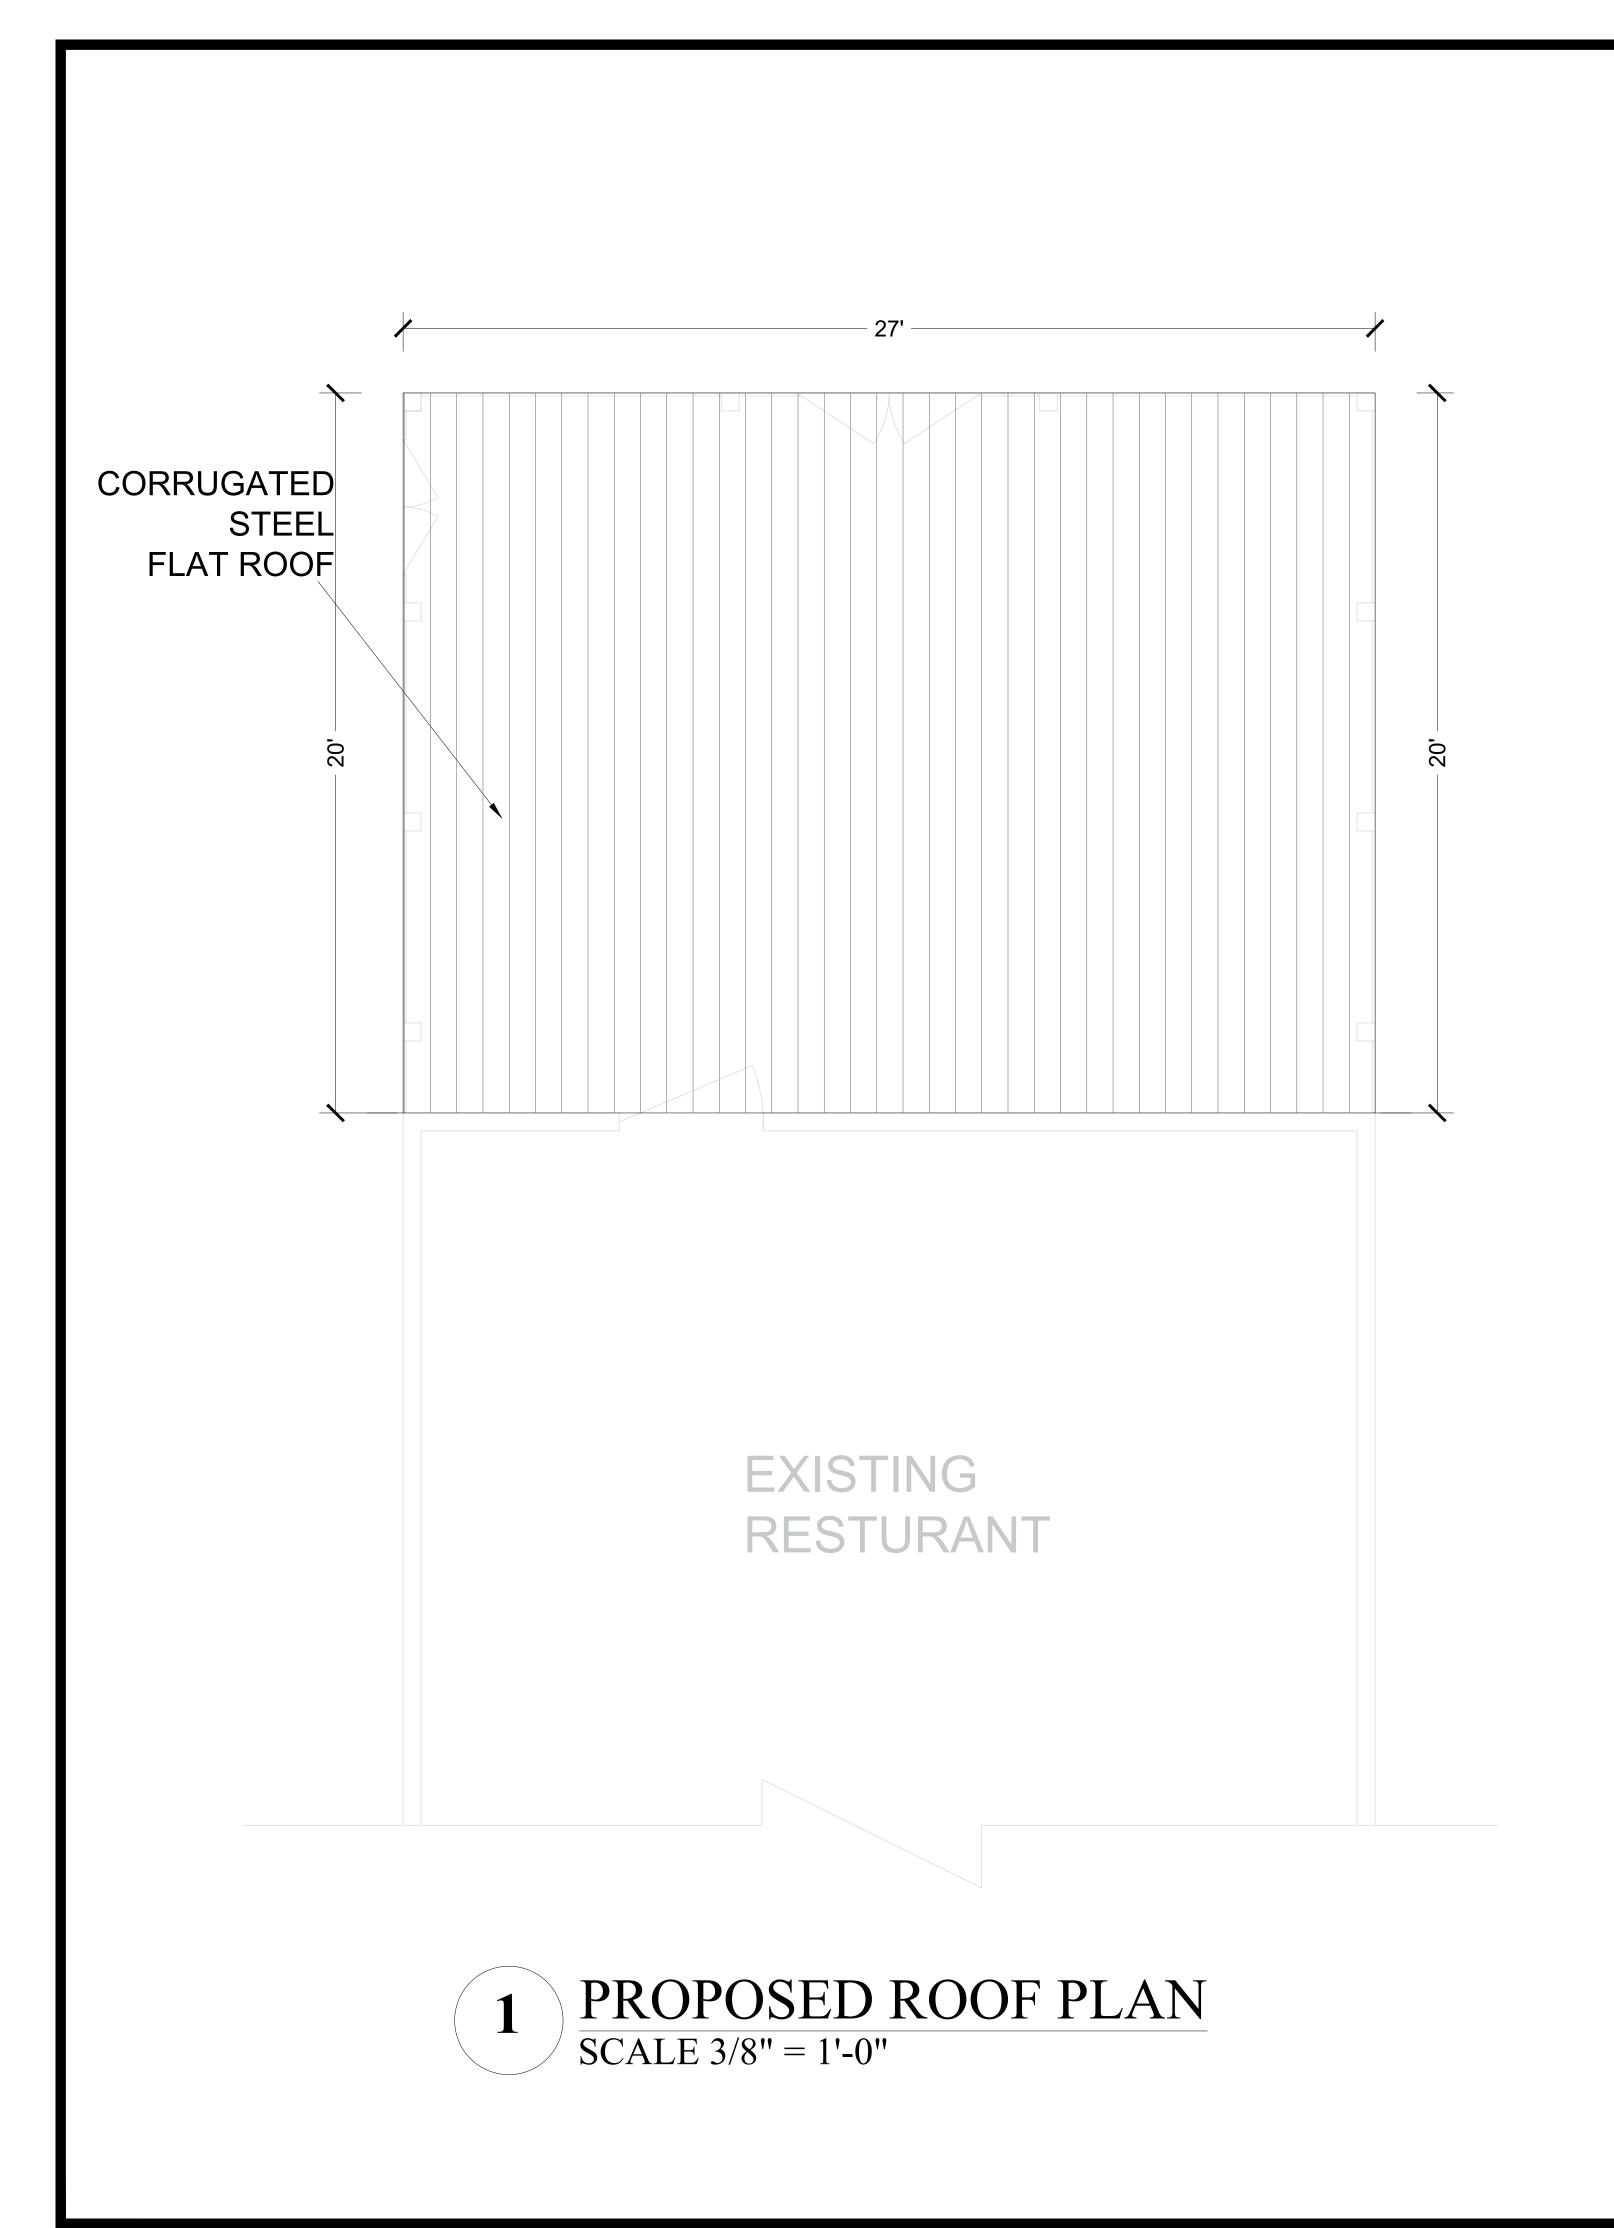

#### **ROOF NOTES:**

- 1. CONTRACTOR SHALL COMPLY WITH ALL APPLICABLE CODES.
- 2. ALL RIDGE BEAMS, HIP RAFTERS, & VALLEY RAFTERS TO BE 2" X 10", NO.2 S.Y.P. UNLESS MENTIONED OTHERWISE OR AS REQ'D BY ENGINEER.
- 3. CONTRACTOR TO WATERPROOF ALL ROOF INTERSECTIONS AS PER CODE.
- 4. CONTRACTOR TO VERIFY ALL ROOF PITCHES WITH EXTERIOR ELEVATIONS PRIOR TO CONSTRUCTION.
- CONTRACTOR TO PROVIDE ADEQUATE ROOF VENTILATION AS PER CODE.



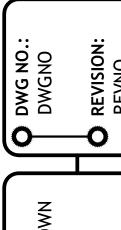

SCALE: AS-SHOWN


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PROJECT ADDRESS:
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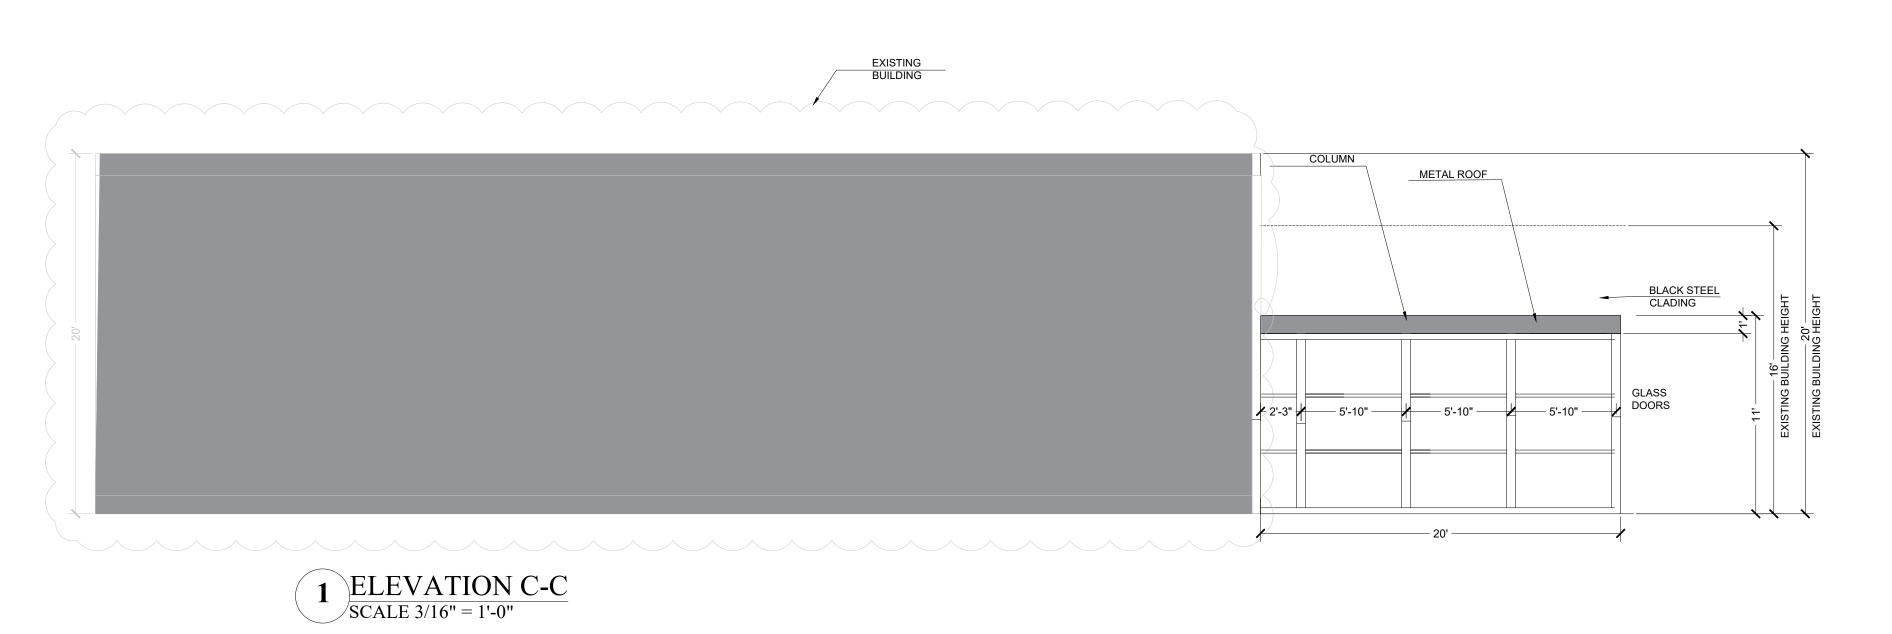
O DRAWING TITLE:
ROOF PLAN

EEAT EFFORT AND CARE HAVE GONE INTO THE PREPARATION OF THIS HOME POSSIBLE TO AFFECT ANY CONTROL OVER THE ACTUAL CONSTRUCTION. FOR AND DUE TO THE MANY JURISDICTIONAL DIFFERENCES IN LOCAL BUILDING EMENTS AND OTHER LOCAL SEISMIC AND WEATHER CONDITIONS, "KAMI MES NO RESPONSILITY FOR ANY DEFICIENCIES, MONETARY OR OTHERWISE, RUCTURAL FAILURES DUE TO ANY DEFICIENCIES, OMISSIONS, OR ERRORS IN HOME PLANS ARE GENERAL IN NATURE. IT IS THE RESPONSIBILITY OF THE JULDER TO CONSULT A LOCAL ARCHITECT OR ENGINEER AND TO CHECK WITHING OFFICIALS BEFORE THE START OF CONSTRUCTION. ADDITIONAL



ENGINEERING SOLUTION




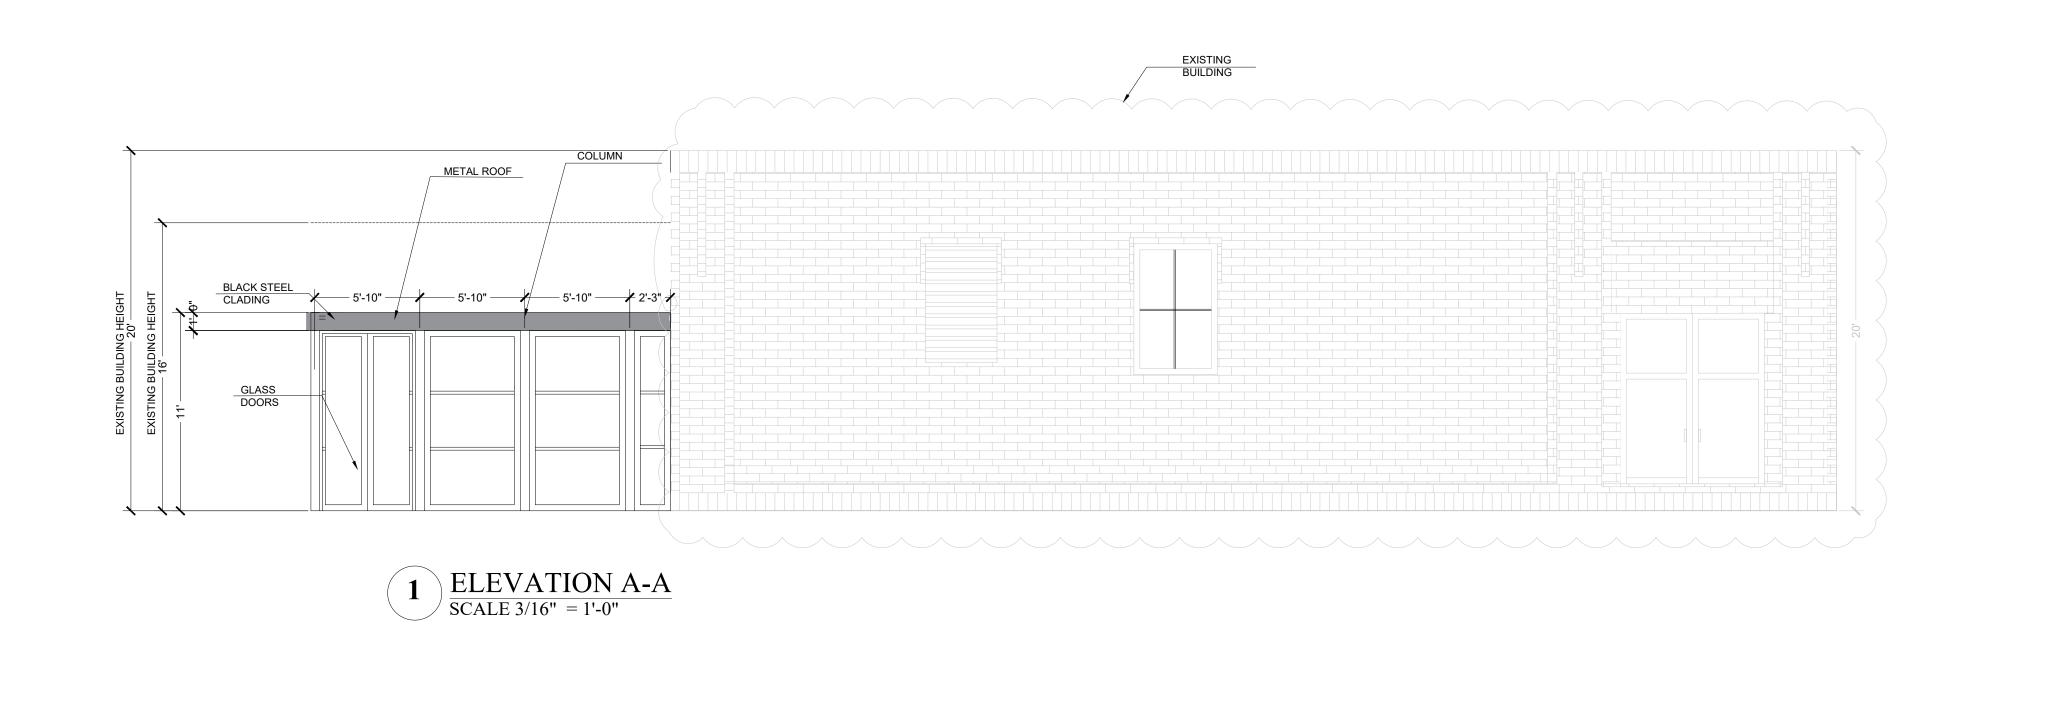







- 1. CONTRACTOR TO VERIFY ALL WINDOW AND DOOR STYLES AND SIZES WITH OWNER PRIOR TO CONSTRUCTION.
- PROVIDE STEPS AND GUARD RAILS AS PER CODE BASED ON SITE CONDITIONS.
   GROUND LINES SHOWN FOR REFERENCE ONLY AND VARY DEPENDING ON SITE CONDITIONS.

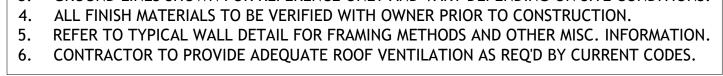


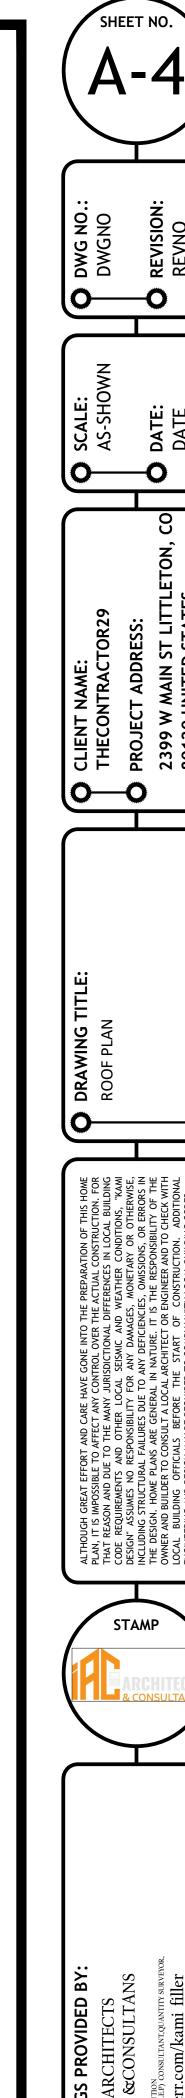

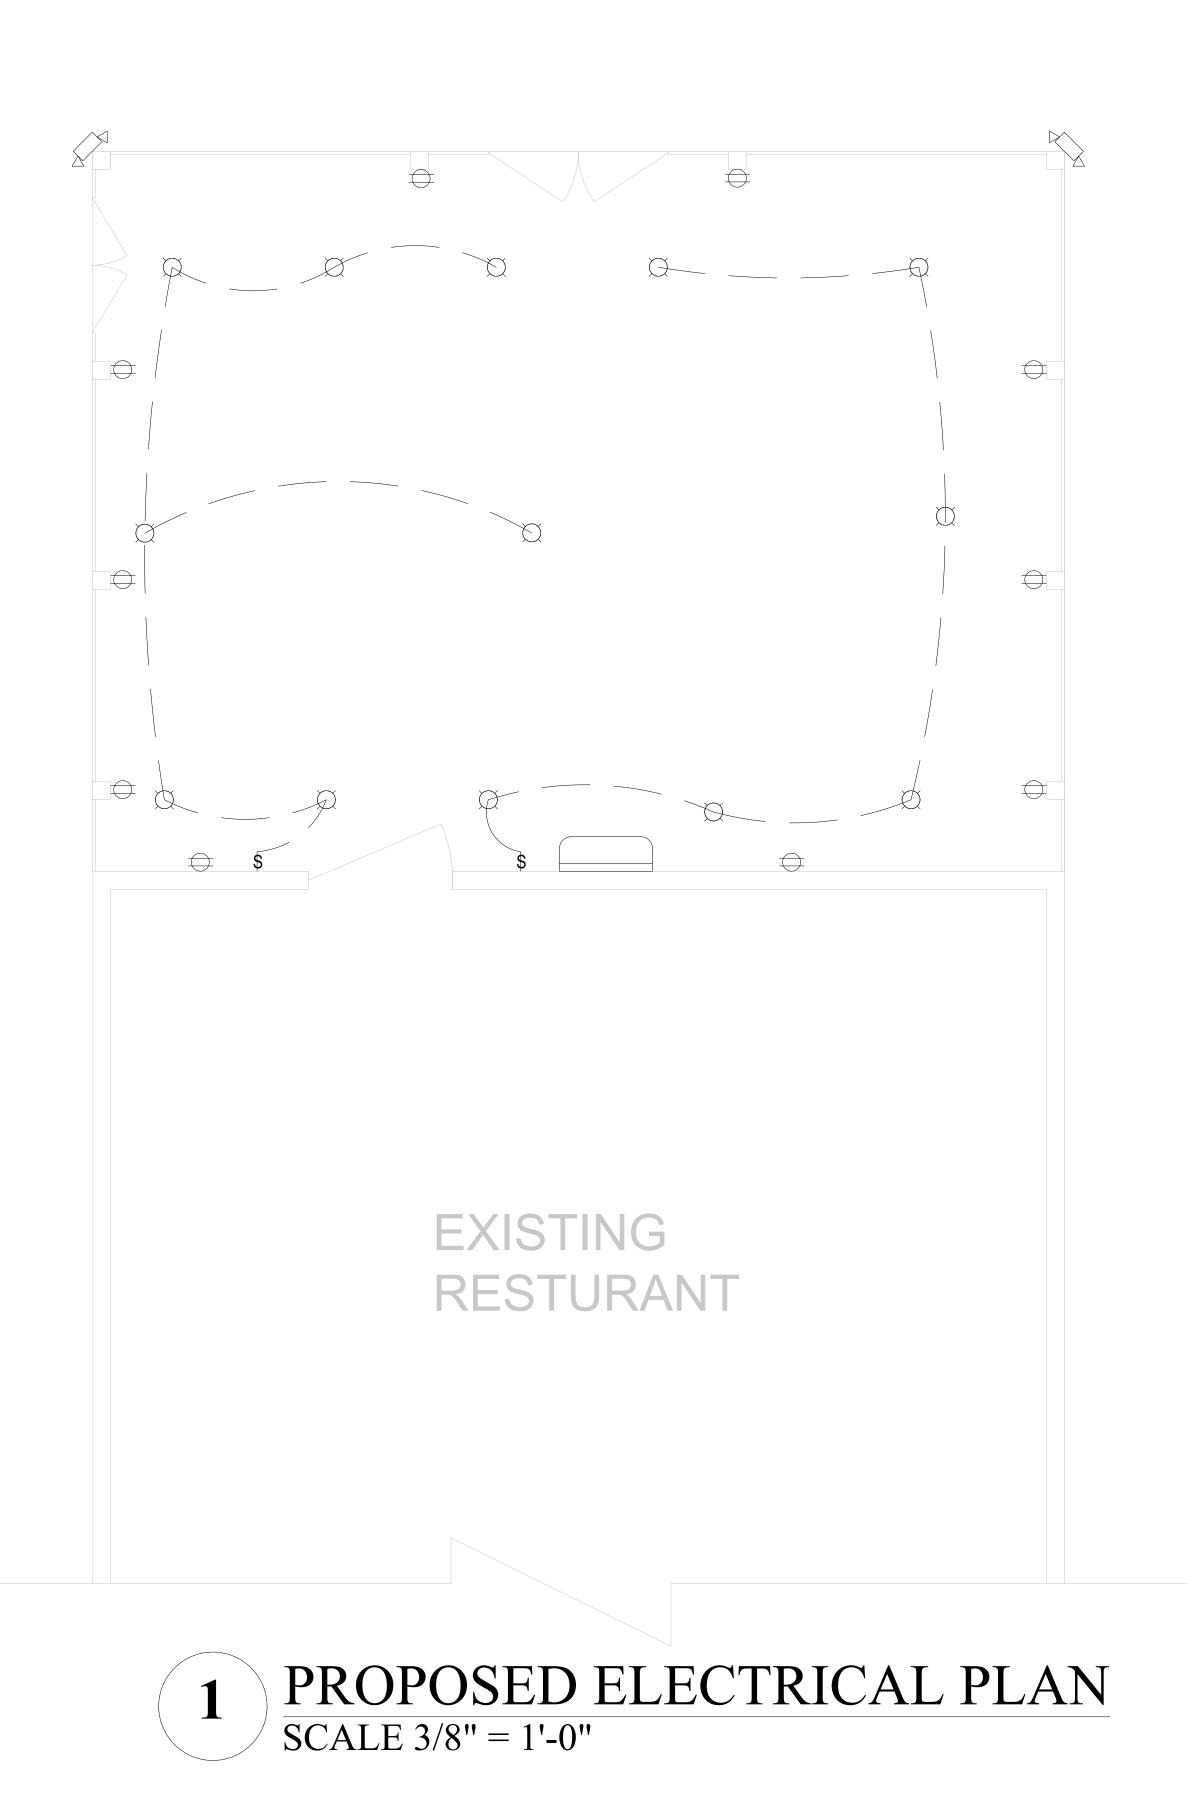


#### **ELECTRICAL NOTES:**

- 1. IT IS THE CONTRACTOR'S RESPONSIBILITY TO FIELD VERIFY THE EXACT LOCATION OF ALL UTILITY SERVICES AND SLOPE PRIOR TO BID/INSTALLATION.
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- . CONTRACTOR SHALL MAKE ALL NECESSARY MODIFICATIONS DURING THE CONSTRUCTION PROCESS TO COMPLY WITH I.R.C. (INTERNATIONAL RESIDENTIAL CODE), LATEST EDITION, OR APPLICABLE CODES AT SITE.
- CONTRACTOR SHALL COORDINATE WITH OTHER TRADES TO ENSURE INSTALLATION IS MADE IN ACCORDANCE WITH THE CONTRACT DOCUMENTS.
- 5. EXACT LOCATIONS AND MOUNTING HEIGHTS OF ALL LIGHTING FIXTURES, WALL OUTLETS, ETC. SHALL BE IN ACCORDANCE WITH THE LOCAL CODE AND THE CONTRACTOR ON SITE SHALL MAKE MODIFICATIONS AS NEEDED.
- 6. ALL LIGHTING CHOICES TO BE OWNER'S CHOICE, BUT TO NOT SURPASS DESIGN STANDARDS.7. ALL WORK SHALL COMPLY WITH ALL CODES APPLICABLE AT SITE.
- 8. SMOKE ALARMS SHALL BE INSTALLED IN THE FOLLOWING LOCATIONS: EACH SLEEPING ROOM, OUTSIDE EACH SEPARATE SLEEPING AREA IN THE IMMEDIATE VICINITY OF THE BEDROOMS, ON EACH ADDITIONAL STORY OF THE DWELLING, INCLUDING BASEMENTS AND HABITABLE ATTICS. WHEN MORE THAN ONE SMOKE ALARM IS REQUIRED TO BE INSTALLED WITHIN A DWELLING THE ALARM DEVICES SHALL BE INTERCONNECTED IS SUCH A MANNER THAT THE ACTUATION OF ONE ALARM WILL ACTIVATE ALL OF THE ALARMS IN THE UNIT. SMOKE ALARMS SHALL BE HARD WIRED WITH A BATTERY BACK UP.
- 9. CARBON MONOXIDE ALARMS SHALL BE INSTALLED OUTSIDE OF EACH SEPARATE SLEEPING AREA IN THE IMMEDIATE VICINITY OF THE BEDROOMS IN DWELLING UNITS WITHIN WHICH FUEL-FIRED APPLIANCES ARE INSTALLED AND IN DWELLING UNITS WITH ATTACHED GARAGES.
- 10. A 125 VOLT, SINGLE PHASE, 15-20 AMPERE RATED RECEPTACLE OUTLET SHALL BE INSTALLED AT AN ACCESSIBLE LOCATION FOR THE SERVICING OF HEATING, AIR CONDITIONING AND REFRIGERATION EQUIPMENT. THE RECEPTACLE SHALL BE LOCATED ON THE SAME LEVEL AND WITHIN 25 FEET OF THE EQUIPMENT. THE RECEPTACLE OUTLET SHALL NOT BE CONNECTED TO THE LOAD SIDE OF THE HVAC EQUIPMENT DISCONNECTING MEANS.

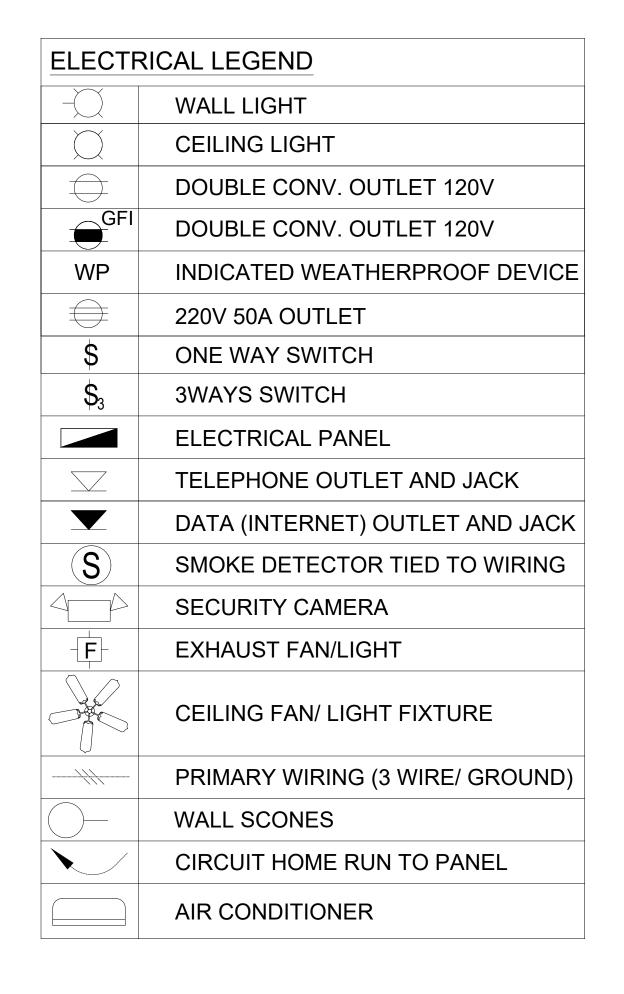



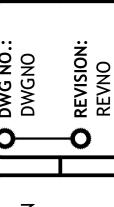



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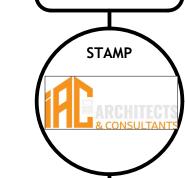
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ARCHITECTS

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